

SITE COVERAGE DETAILS

 $725 \, m^2$ OVERALL SITE AREA:

EXISTING DWELLING: EXISTING CLASS 10: PROPOSED SSD: PROPOSED SSD PORCH: 3 m²

PROPOSED SSD DECKING: 19 m² 270 m² (37%) OVERALL SITE COVERAGE:

TOTAL PERMEABLE AREA: 273 m² (38%)

 TOTAL GARDEN AREA:
 265 m² (37%)

 TOTAL PRIVATE OPEN SPACE:
 455 m² (63%)

 TOTAL S.P.O.S:
 48 m² (7%)



Callen Bray

Building Design & Drafting Residential - Commercial - Industrial RESIGENTIAI - COMMERCIAI - INGUSTRIAI
ABN: 38 040 205 161
Phone: 0419 441 186
Email: Callen Bray@Hotmail.com
Registered Building Practitioner: DP-AD 36967

Proposed SSD,

For: Betnale Pty. Ltd.

At: Lot 23, No. 919 Mountain Hwy, Bayswater, VIC 3153

7.13m x 8.2m 2 Bedroom

Sheet No: 1 Issue: 12/05/25 Rev: 01

 $133 \, \mathrm{m}^2$

58 m² (+44%)

 57 m^2

WATERPROOFING & WATER RESISTANCE **SPECIFICATION** ALL WET AREA FLOORS: <u>FOOTINGS</u> ENSURE VINYL FLOORING IS DEEMED TO BE WATERPROOF & THAT ALL JOINS ARE SEALED AS PER SOIL REPORT BY SOIL TEST MELBOURNE WALERPROOF & HAI ALL JOINS ARE SEALED UPTURN VINIX MIN. 25 EARN AT WALL/FLOOR JUNCTIONS TO CREATE WATERPROOF WATER STOP, SKIRTING BOARDS & ARCHITRAVES PLACED OVER UPTURN & SEALED TO VINIX WITH WATERPROOF ACRYLIC OR SILICONE SEALANT (REFER TO DETAIL) SITE CLASSIFICATION MIN. DEPTH 1800mm SKIRTING BOARDS & ARCHITRAVES TO WET AREAS TO BE SOLID TIMBER (IE. PINE OR HARDWOOD, NOT MDF) <u>STUMPS</u> A1: 42mm x 3.2mm Mega-Anchor 42x42x3mm ALUMIN. WATERSTOP ANGLE OR VINYL FLOORING STRIP WITH MIN. HORIZONTAL DIMENSION https://www.mega-anchor.com.au/products OF 40mm EITHER SIDE, SEALED TO WALL AT ALL WALL JUNCTIONS (CORNERS) EXTENDING A MIN. OF 1800mr S1: 75x75x8mm GALVANISED STEEL STUMPS WITH 130x130x8mm WELDED BASE PLATE & 200x75x10mm FABRICATED SLOT IN "T OP. EMBED IN FOOTINGS TO ENGINEERS SPECIFICATION. FROM SHOWER BASE THERMOSET LAMINATE WALL PANELS MIN. OF 1800mm HIGH FROM SHOWER BASE C1: 100x100 PRECAST CONCRETE STUMPS WITH ONE ABOVE BASINS, TROUGHS & SINKS (KITCHEN BENCH) ALL VESSELS ARE PROVIDED WITH IN-BUILT OVERFLOW PROTECTION OR HAVE A PERMANENT OPEN TRAPPED CONNECTION TO THE PLUMBING AND DRAINAGE P1: 100x100 Cypress timber Posts/Newel Posts with a Min. Stress grade of F4 on CONCRETE FOOTING WITH POST ANCHOR. 150mm HIGH WALL TILES MIN. ABOVE VESSELS WITH WATERPROOF ACRYLIC OR SILICONE SEALANT TO **BEARERS** $2/140x45\ \text{LVL}\ 15$ (F17) BEARERS WITH A MAX. CONTINUOUS SPAN OF 2400mm. ELECTRICAL NOTES LIGHT SWITCHES TO BE AT 1000mm ABOVE FLOOR LEVEL. HEIGHTS OF POWER POINTS MEASURED FROM MINIMUM BEARER CLEARANCE FLOOR LEVEL UNLESS OTHERWISE NOTED. TO GROUND LEVEL: JNLESS DIMENSIONED POWER POINTS TO BE OCATED TO THE NEAREST STUD TERMITE INSPECTION POWER POINTS FOR APPLIANCES & SPLIT SYSTEM AIR-CONDITIONING TO SUIT MANUFACTURERS REQ. PROVIDE PHONE CABLING WITH CONDUIT & DRAW NOT REQUIRED: 150mm STRING PLUS T.V. ANTENNA CABLING THROUGH BARGE END. NOTE: ON SLOPING SITES, 400mm WHEN REQUIRED MAY BE REDUCED TO 150mm WITHIN 2m OF EXTERNAL WALLS **ENERGY EFFICIENCY-LIGHTING** ARTIFICIAL LIGHTING MUST PROVIDE AT LEAST: **FLOOR JOISTS** 90x45 MGP10 FLOOR JOISTS AT ONE LIGHT FITTING PER 16m2 WHERE NATURAL LIGHT IS INSUFFICIENT TO PROVIDE SAFE MOVEMENT OF OCCUPANTS IN ACCORDANCE WITH NCC 2022 PART 14 AND ABCB HOUSING PROVISIONS PART 10.5 MAX. CONTINUOUS OF 1800mm **FLOORING** PROPOSED MAX. WATTAGE CALCULATED TO 19mm THICK "YELLOW TONGUE" PARTICLEBOARD FLOORING. 4W/m² ON A VERANDAH, BALCONY, OR THE LIKE ATTACHED TO A SOLE-OCCUPANCY UNIT TIMBER DURABILITY INTERNAL LIGHTING MUST NOT EXCEED: 290 WATTS TOTAL CLASS 1 OR 2 TIMBERS ARE SUITABLE FOR IN GROUND CLASS 1 CLASS 2 **ELECTRICAL LEGEND** BELIAN BLACKBUTT CYPRESS (WHITE) IRONBARK TALLOWWOOD TURPENTINE KWILA (MERBAU) - LED DOWNLIGHT - PHONE POINT AT 200/1000 SPOTTED GUM WESTERN RED CEDAR RIVER RED GUM YELLOW CEDAR NORTHERN BOX Balau Teak (SELF SEALING) **WALL FRAMES** SWITCH BOARD COMMON STUDS: 90x35 MGP10 TOP/BOTTOM PLATES: 90x35 AT 1275 CTS. SPP DPP HEIGHT JAMB STUDS: OPENING 0 - 900: 90x35 MGP10 OPENING 900 - 2600: OPENING 2600 - 4300 200 F.F.L 🖎 🕰 1200 F.F.L △ 1275 F.F.l 350 F.F.L **LINTELS** △ 1350 F.F.L △ 970 F.F.L △ △ 1400 F.F.L 90 x 45 F5 90 x 45 LVL 15 140 x 45 F7 OPENINGS UP TO 1100 DPENINGS UP TO 1500 △ | 1000 F.G.L | △ | 2000 F.F.L OPENINGS UP TO 1800: OPENINGS UP TO 2200 140 x 45 LVL 15 △ 1000F.F.L IN ROOF OPENINGS UP TO 2400 190 x 45 MGP10 240 x 45 F7 OPENINGS UP TO 3000: THE PLACEMENT OF A CHEMICAL BARRIER OR SHEET METAL "ANT CAPS" TO THE TOPS OF TIMBER STUMPS IN ACCORDANCE WITH PART 3.1.3 OF THE BCA & AS 3660.1 IS SUFFICIENT WHEN PROTECTION AGAINST TERMITE *ALL STRUCTURAL TIMBER SIZES, FIXINGS & TIE-DOWNS ARE TO BE IN ACCORDANCE WITH AS 1684.2 2021 TTACK IS REQUIRED **BUSHFIRE AREAS** IOTE: A MIN. OF 400mm CLEARANCE IS REQUIRED TO DESIGN & SPECIFICATION DOES NOT CONSIDER SITES THE UNDERSIDE OF BEARERS ON SITES REQUIRING TERMITE INSPECTION. THIS CAN BE REDUCED TO 150mm ON SLOPING SITES WITHIN HAVE A BAL OF 12.5 OR MORE HAVE ADDITIONAL CONSTRUCTION REQUIREMENTS IN ACCORDANCE WITH 2m OF EXTERNAL WALLS. NCC 2022 PART H7D4 & AS 3959 INTERNAL ELEVATIONS SPECIFICATION WATER PIPE LOCATIONS FITTING LOCATIONS ABOVE FFL No. ITEM ABOVE FFL HEIGHT ABOVE FFL 6 SINK 600 BIDET 7 DW 500 TOWEL RAIL 1000/1600 1085 BATH 600 TROUGH TOWEL RING 820 SHOWER 1000/1800 9 WM SHOWER SOAP HOLDER 1000 NOMINAL 600/1275 10 FR WASTE FRAME OFFSETS: SHOWER ROSE = 430 CL, SHOWER TAPS = 250 CL, SOAP HOLDER = 550 CL

- SPLASHBACK TILES: 200x200


- WET AREA SKIRTING BOARDS:

Sub-Floor Plan

Scale 1:100 @ A2

NOTES: - DIMENSIONS TAKEN FROM FRAME

- POWERPOINT LOCATION

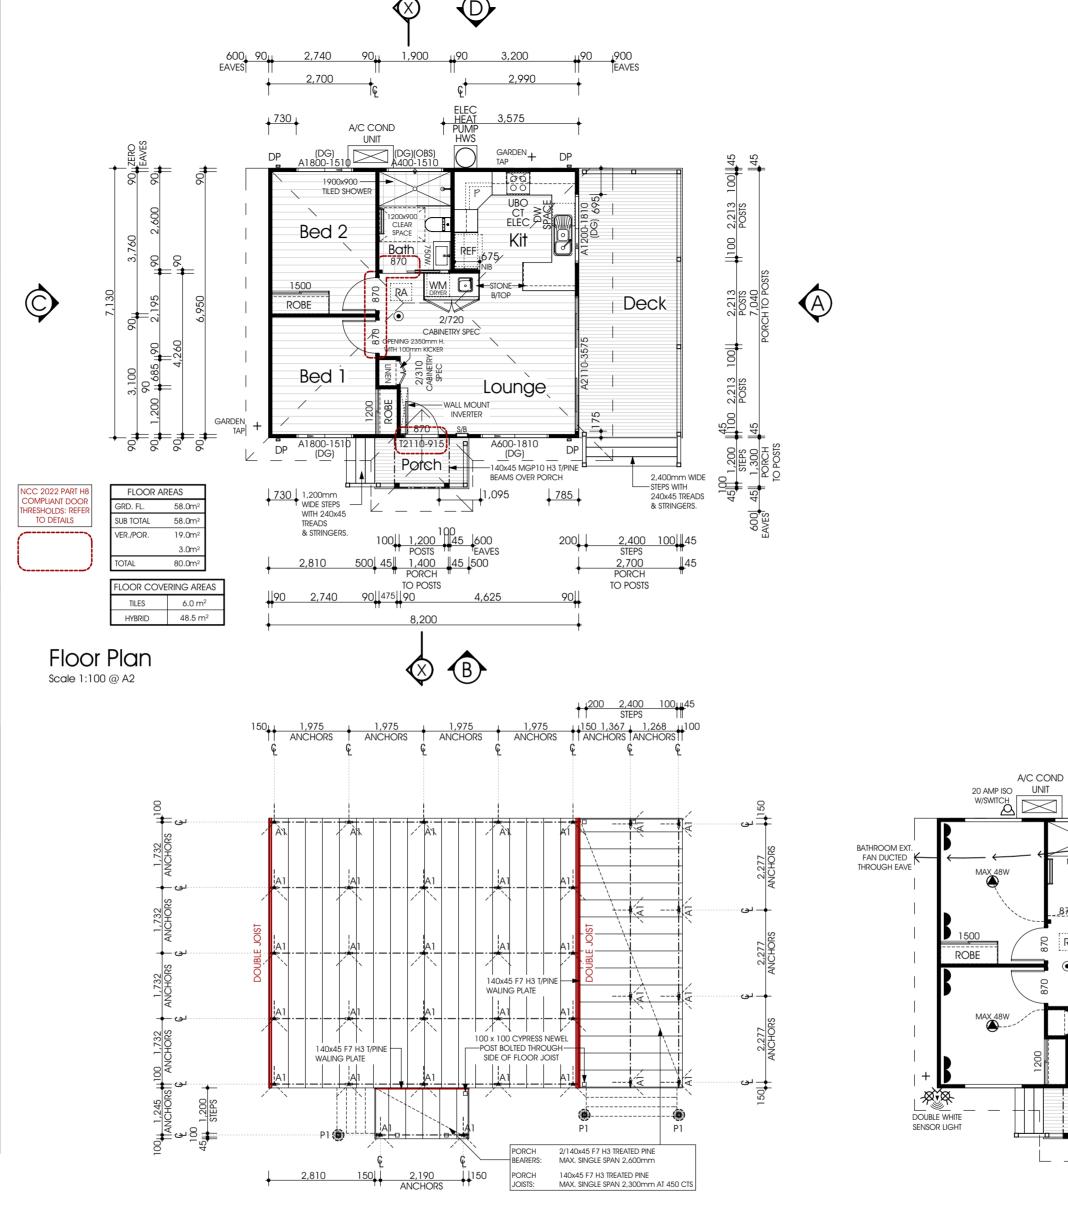

Electrical Plan Scale 1:100 @ A2

SIGNED:

I/WE . ACKNOWLEDGE THAT THESE PLANS ARE A TRUE AND ACCURATE REFLECTION OF OUR REQUIREMENTS AND AGREE THAT THESE PLANS ARE THE PLANS REFFERED TO IN THE MAJOR DOMESTIC BUILDING CONTRACT BETWEEN "BETNALE PTY LTD" (TRADING AS SUPERIOR GRANNY FLATS) AND MYSELF/OURSELVES AND AUTHORISE THEIR USE FOR NEXT STAGE PURPOSES. I/WE AM/ARE FULLY AWARE, IF ANY FURTHER CHANGES ARE TO BE MADE ON THESE PLANS WILL INCUR A VARIATION FEE. . DATE: SIGNED:



Callen Bray

ENERGY EFFICIENCY

ROOF, WALL & FLOOR SYSTEMS

INSULATION VALUES

BUILDING SEALING

SERVICES

GENERAL NOTES

CALCULATIONS FOR DETAILS.

WINDOW GLAZING CODES:

- STEPS: TREAD- 240mm MIN, RISER- 190mm MAX

WALLS: R- 2.5 WALL BATTS (90mm)

CLASS 1 BUILDINGS IN CLIMATE ZONE 6 ARE REQUIRED TO ACHIEVE A MIN. 7 STAR

ROOF: R- 5.0 BATTS (210mm) + REFLECTIVE FOIL INSULATION*

* NOTE: REFLECTIVE FOIL INSULATION ASSUMES A SINGLE FOIL SIDED TYPE & POLY WEAVE BACKED WITH AN AVERAGE EMITTANCE VALUE OF 0.9 OUTER & 0.05 INNER. THE REFLECTIVE SIDE MUST FACE DOWNWARD (ROOF) OR INWARD (WALLS) AND BE PLACED DIRECTLY UNDER THE ROOF & WALL CLADDING TO BE EFFECTIVE

EXTERNAL GLAZING IS SUBJECT TO BUILDING ORIENTATION; REFER TO ATTACHED GLAZING CALCULATION FOR SPECIFIC BUILDING ORIENTATION

- A SEAL TO RESTRICT AIR INFILITRATION MUST BE FITTED TO EACH EDGE OF AN EXTERNAL SUIDING DOOR, WINDOWS AND OPENINGS.
- DRAFT PROTECTORS ARE REQUIRED TO BE FITTED TO THE BOTTOM EDGE OF EXTERNAL SWING DOORS AND SEALS TO THE HEAD AND SIDES.
- SEALS MAY BE FOAM, RUBBER, FIBROUS OR THE LIKE.
- EXHAUST FANS MUST BE FITTED WITH A SELF SEALING DEVICE SUCH AS A SELF-CLOSING DAMPER OR FILTER (RANGEHOOD)
- GAPS AND CRACKS AROUND ROOFS, EXTERNAL FLOORS, WALL/FLOOR/ROOF JUNCTIONS AND AROUND WINDOW AND DOOR FRAMES MUST BE MINIMISED THROUGH GOOD CONSTRUCTION PRACTICE. AND WITH THE PLACTING OF CLOSE FITTING INTERNAL LINING AT JUNCTIONS, CAULKING, SKIRTING, ARCHITRAVES AND CORNICES.

- SERVICES PIPING AND DUCTWORK MUST BE INSTALLED TO FACILITATE THE EFFICIENT USE OF ENERGY AS PER HOUSING PROVISIONS PART 13.7.

WITH NCC 2022 PART H6: REFER TO ENERGY EFFICIENCY NOTES & GLAZING

- WET AREAS PROTECTED WITH A WATERPROOFING SYSTEM IN ACCORDANCE WITH NCC 2022 PART H4D2 AND HOUSING PROVISIONS PART 10.2.

WHERE REQUIRED, HORIZONTAL & VERT. GAPS IN BALUSTRADES MUST BE LESS

THAN 125mm IN ACCORDANCE WITH HOUSING PROVISIONS PART 11.3.4

- INTERNAL 90mm STUD

WC / BATHROOM DOOR TO BE REMOVABLE WHERE REQUIRED AND FITTED WITH LIFT OFF HINGES IN ACCORDANCE WITH ABCB HOUSING PROVISIONS PART 10.4.2

- MECHANICAL VENTILATION TO OUTSIDE AIR PROVIDED WHERE REQUIRED AND IN ACCORDANCE WITH NCC 2022 PART H4D7

- (OBS) OBSCURE GLASS - (TLS) TRANSLUCENT GLASS - (DG) DOUBLE GLAZED

RA: - ROOF ACCESS (WHERE APPLICABLE)

- SMOKE DETECTOR (DIRECT WIRED)

□ DP - DOWNPIPE (STORMWATER CONNECTED)

■ DP - DOWNPIPE (WATER TANK CONNECTED)

- ROOF TRUSSES (WHERE USED) TO HAVE A MAXIMUM SPACING OF 900mm

WRITTEN DIMENSIONS WILL TAKE PRECEDENCE OVER SCALE.

- UNLESS OTHERWISE INDICATED ALL WALL DIMENSIONS ARE:

ALL GLAZING TO COMPLY WITH NCC 2022 PART H1D8 & AS 1288

ENERGY EFFICIENCY (WALL, FLOOR, ROOF INSULATION & GLAZING) IN ACCORDANCE

- AT STEPS- 865mm (MIN) HIGH - AT LANDING- 1000mm (MIN) HIGH

FLOOR: R- 2.9 REFLECTIVE FOIL INSULATION (4mm)

ENERGY RATING IN ACCORDANCE WITH NCC 2022 PART H6. THIS IS ACHIEVED USING THE (DEEMED TO SATISFY PROVISIONS) OF PART 13.2 OF THE ABCB HOUSING PROVISIONS

REFÉR TO ATTACHED REPORT FOR EXPLANATORY INFORMATION & OVERALL R-VALUES OF

Building Design & Drafting Residential - Commercial - Industrial ABN: 38 040 205 161

Proposed SSD,

For: Betnale Pty. Ltd.

RANGEHOOD EXT. FAN

-DUCTED THROUGH WALL

DOUBLE WHITE

NGEHOOD

OVER COOKTOP

ELEC HEAT PUMF HWS

WALL MOUNT

SPOTLIGHT

UNIT

2 Bedroom

7.13m x 8.2m

Sheet No: 2 Issue: 12/05/25 Rev: 01

At: Lot 23, No. 919 Mountain Hwv, Bayswater, VIC 3153

. DATE:

SPECIFICATION

<u>FOOTINGS</u>

AS PER SOIL REPORT BY SOIL TEST MELBOURNE

SITE CLASSIFICATION MIN. DEPTH 1800mm

<u>STUMPS</u>

A1: 42mm x 3.2mm Mega-Anchor

https://www.mega-anchor.com.au/products S1: 75x75x8mm GALVANISED STEEL STUMPS WITH 130x130x8mm WELDED BASE PLATE & 200x75x10mm FABRICATED SLOT IN "T" TOP. EMBED IN FOOTINGS TO ENGINEERS SPECIFICATION.

C1: 100x100 PRECAST CONCRETE STUMPS WITH ONE 5mm HARD DRAWN WIRE.

P1: 100x100 Cypress timber Posts/Newel Posts with a Min. Stress grade of F4 on CONCRETE FOOTING WITH POST ANCHOR.

<u>BEARERS</u>

2/140x45 LVL 15 (F17) BEARERS WITH A MAX. CONTINUOUS SPAN OF 2400mm.

MINIMUM BEARER CLEARANCE TO GROUND LEVEL:

ERMITE INSPECTION NOT REQUIRED:

150mm

NOTE: ON SLOPING SITES, 400mm WHEN REQUIRED MAY BE REDUCED TO 150mm WITHIN 2m OF EXTERNAL WALLS

90x45 MGP10 FLOOR JOISTS AT MAX. 450 CENTRES WITH A: MAX. CONTINUOUS OF 1800mm MAX. SINGLE SPAN OF 1300mm

FLOORING

FLOOR JOISTS

19mm THICK "YELLOW TONGUE" PARTICLEBOARD FLOORING.

TIMBER DURABILITY

CLASS 1 OR 2 TIMBERS ARE SUITABLE FOR IN GROUND

CLASS 1	CLASS 2
BELIAN CYPRESS (WHITE) IRONBARK TALLOWWOOD TURPENTINE	BLACKBUTT KWILA (MERBAU) SPOTTED GUM WESTERN RED CED RIVER RED GUM
YELLOW CEDAR	BALAU
NORTHERN BOX	TEAK

WALL FRAMES

- COMMON STUDS:	90x35 MGP10 AT 600 CTS.
- TOP/BOTTOM PLATES: - NOGGINGS:	45x90 MGP10 90x35 AT 1275 CTS
- Jamb Studs: Opening 0 - 900: Opening 900 - 2600: Opening 2600 - 4300:	90x35 MGP10 2/90x35 MGP10 3/90x35 MGP10

LINTELS

LIIVIELS	
- OPENINGS UP TO 1100:	90 x 45 F5
- OPENINGS UP TO 1500:	90 x 45 LVL 15
- OPENINGS UP TO 1800:	140 x 45 F7
- OPENINGS UP TO 2200:	140 x 45 LVL 15
- OPENINGS UP TO 2400:	190 x 45 F7
- OPENINGS UP TO 2600:	190 x 45 MGP1
- OPENINGS UP TO 3000:	240 x 45 F7

*ALL STRUCTURAL TIMBER SIZES, FIXINGS & TIE-DOWNS ARE TO BE IN ACCORDANCE WITH AS 1684.2 2021

BUSHFIRE AREAS

DESIGN & SPECIFICATION DOES NOT CONSIDER SITES SUBJECT TO BUSHFIRE ATTACK. SITES DEEMED TO HAVE A BAL OF 12.5 OR MORE HAVE ADDITIONAL ONSTRUCTION REQUIREMENTS IN ACCORDANCE WITH NCC 2022 PART H7D4 & AS 3959

WATERPROOFING & WATER RESISTANCE ALL WET AREA FLOORS:

ENSURE VINYL FLOORING IS DEEMED TO BE ENSURE VIEW I-LOCKING IS DEENIED IO BE WATERPROOF & THAT ALL JOINS ARE SEALED UPTURN VINYL MIN. 25mm AT WALL/FLOOR JUNCTIONS TO CREATE WATERPROOF WATER STOP. SKIRTING BOARDS & ARCHITRAVES PLACED OVER UPTURN & SEALED TO VINYL WITH WATERPROOF ACRYLIC OR SILICONE SEALANT (REFER TO DETAIL)
SKIRTING BOARDS & ARCHITRAVES TO WET AREAS TO BE SOLID TIMBER (IE. PINE OR HARDWOOD, NOT MDF)

42x42x3mm ALUMIN. WATERSTOP ANGLE OR VINYL FLOORING STRIP WITH MIN. HORIZONTAL DIMENSION OF 40mm EITHER SIDE, SEALED TO WALL AT ALL WALL JUNCTIONS (CORNERS) EXTENDING A MIN. OF 1800m FROM SHOWER BASE
THERMOSET LAMINATE WALL PANELS MIN. OF 1800mm
HIGH FROM SHOWER BASE

ABOVE BASINS, TROUGHS & SINKS (KITCHEN BENCH)

ALL VESSELS ARE PROVIDED WITH IN-BUILT OVERFLOW PROTECTION OR HAVE A PERMANENT OPEN TRAPPED CONNECTION TO THE PLUMBING AND DRAINAGE 150mm HIGH WALL TILES MIN. ABOVE VESSELS WITH WATERPROOF ACRYLIC OR SILICONE SEALANT TO JUNCTIONS

ELECTRICAL NOTES

- LIGHT SWITCHES TO BE AT 1000mm ABOVE FLOOR LEVEL. - HEIGHTS OF POWER POINTS MEASURED FROM FLOOR LEVEL UNLESS OTHERWISE NOTED. - UNLESS DIMENSIONED POWER POINTS TO BE LOCATED TO THE NEAREST STUD. SPLIT SYSTEM AIR-CONDITIONING TO SUIT MANUFACTURERS REQ. PROVIDE PHONE CABLING WITH CONDUIT & DRAW

STRING PLUS T.V. ANTENNA CABLING THROUGH

ENERGY EFFICIENCY-LIGHTING

ARTIFICIAL LIGHTING MUST PROVIDE AT LEAST:

ONE LIGHT FITTING PER 16m²

WHERE NATURAL LIGHT IS INSUFFICIENT TO PROVIDE SAFE MOVEMENT OF OCCUPANTS IN ACCORDANCE WITH NCC 2022 PART H4 AND ABCB HOUSING PROVISIONS PART 10.5

PROPOSED MAX. WATTAGE CALCULATED TO NCC VOL. 1 PART J7D3

W/m² WITHIN A SOLE-OCCUPANCY UNIT; AND 4W/m² ON A VERANDAH, BALCONY, OR THE LIKE ATTACHED TO A SOLE-OCCUPANCY UNIT

INTERNAL LIGHTING MUST NOT EXCEED: 290 WATTS TOTAL

ELECTRICAL LEGEND - SMOKE DETECTOR (SELF SEALING) - T.V. POINT

		CH BOARD	' '	AT 200	
SPP	DPP	HEIGHT	SPP	DPP	HEIGHT
		200 F.F.L	\otimes	<u> </u>	1200 F.F.L
		350 F.F.L		4	1275 F.F.L
Ω	•	750 F.F.L	Q	•	1350 F.F.L
		970 F.F.L	0		1400 F.F.L
2	<u> </u>	1000 F.G.L	0		2000 F.F.L
		1000F.F.L	777		IN ROOF

TERMITE AREAS


THE PLACEMENT OF A CHEMICAL BARRIER OR SHEET METAL "ANT CAPS" TO THE TOPS OF TIMBER STUMPS IN ACCORDANCE WITH PART 3.1.3 OF THE BCA & AS 3660.1 IS SUFFICIENT WHEN PROTECTION AGAINST TERMITE TTACK IS REQUIRED


NOTE: A MIN. OF 400mm CLEARANCE IS REQUIRED TO THE UNDERSIDE OF BEARERS ON SITE REQUIRING TERMITE INSPECTION. THIS CAN BE REDUCED TO 150mm ON SLOPING SITES WITHIN 2m OF EXTERNAL WALLS.


INTERNAL ELEVATIONS SPECIFICATION


WATER PIPE LOCATIONS			FITTING LOCATIONS				
No.	ITEM	ABOVE FFL	No.	ITEM	ABOVE FFL	ITEM	HEIGHT ABOVE FFL
1	TOILET	250	6	SINK	650	PAPER HOLDER	600
2	BIDET	250	7	DW	500	TOWEL RAIL	1000/1600
3	BATH	600	8	TROUGH	1085	TOWEL RING	820
4	SHOWER	1000/1800	9	WM	600/1275	SHOWER SOAP HOLDER	1000 NOMINAL
5	BASIN	600	10	FR WASTE	-		
	FRAME OFFSETS: SHOWER ROSE = 430 CL, SHOWER TAPS = 250 CL, SOAP HOLDER = 550 CL						



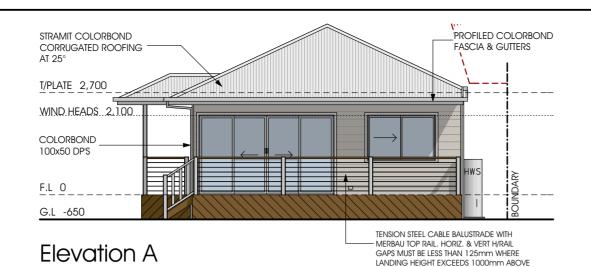

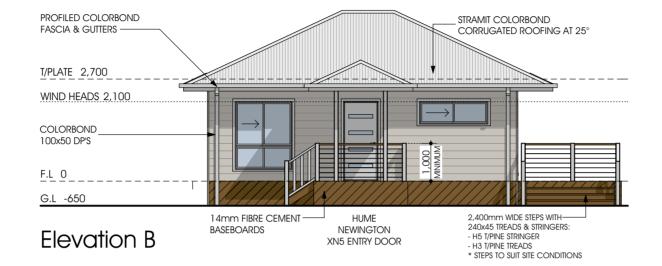


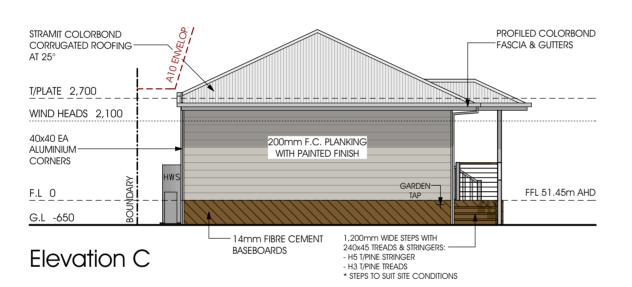

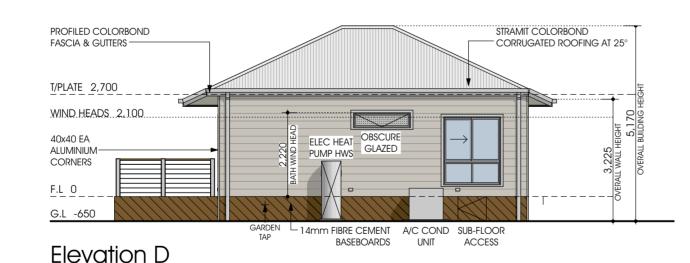

Elevations

Scale 1:100 @ A2

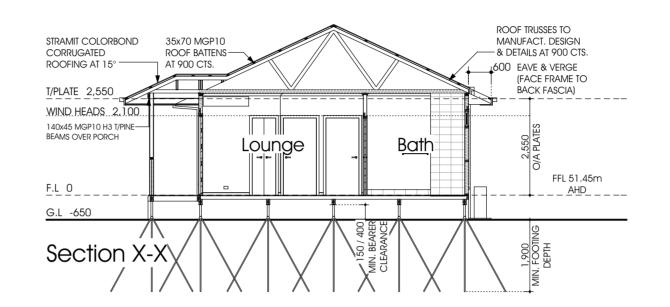

ENERGY EFFICIENCY

CLASS 1 BUILDINGS IN CLIMATE ZONE 6 ARE REQUIRED TO ACHIEVE A MIN. 7 STAR ENERGY RATING IN ACCORDANCE WITH NCC 2022 PART H6. THIS IS ACHIEVED USING THE (DEEMED TO SATISFY PROVISIONS) OF PART 13.2 OF THE ABCB HOUSING PROVISIONS REFÈR TO ATTACHED REPORT FOR EXPLANATORY INFORMATION & OVERALL R-VALUES OF ROOF, WALL & FLOOR SYSTEMS

INSULATION VALUES

ROOF: R- 5.0 BATTS (210mm) + REFLECTIVE FOIL INSULATION*

WALLS: R- 2.5 WALL BATTS (90mm)

FLOOR: R- 2.9 REFLECTIVE FOIL INSULATION (4mm)

NOTE: REFLECTIVE FOIL INSULATION ASSUMES A SINGLE FOIL SIDED TYPE & POLY WEAVE BACKED WITH AN AVERAGE EMITTANCE VALUE OF 0.9 OUTER & 0.05 INNER. THE REFLECTIVE SIDE MUST FACE DOWNWARD (ROCO) FOR INWARD (WALLS) AND BE PLACED DIRECTLY UNDER THE ROOF & WALL CLADDING TO BE EFFECTIVE

EXTERNAL GLAZING IS SUBJECT TO BUILDING ORIENTATION; REFER TO ATTACHED GLAZING CALCULATION FOR SPECIFIC BUILDING ORIENTATION

A SEAL TO RESTRICT AIR INFILITATION MUST BE FITTED TO EACH EDGE OF AN EXTERNAL SUIDING DOOR, WINDOWS AND OPENINGS.

- DRAFT PROTECTORS ARE REQUIRED TO BE FITTED TO THE BOTTOM EDGE OF EXTERNAL SWING DOORS AND SEALS TO THE HEAD AND SIDES.

- SEALS MAY BE FOAM, RUBBER, FIBROUS OR THE LIKE.

- EXHAUST FANIS MUST BE FITTED WITH A SELF SEALING DEVICE SUCH AS A SELF-CLOSING DAMPER OR FILTER (RANGEHOOD)

- GAPS AND CRACKS AROUND ROOFS, EXTERNAL FLOORS, WALLIFLOOR/ROOF JUNCTIONS AND AROUND WINDOW AND DOOR FRAMES MUST BE MINIMISED THROUGH GOOD CONSTRUCTION PRACTICE. AND WITH THE PLACING OF CLOSE FITTING INTERNAL LINING AT JUNCTIONS, CAULKING, SKIRTING, ARCHITRAVES AND CORNICES.

SERVICES

- SERVICES PIPING AND DUCTWORK MUST BE INSTALLED TO FACILITATE THE EFFICIENT USE OF ENERGY AS PER HOUSING PROVISIONS PART 13.7.

GENERAL NOTES

ENERGY EFFICIENCY (WALL, FLOOR, ROOF INSULATION & GLAZING) IN ACCORDANCE WITH NCC 2022 PART H6: REFER TO ENERGY EFFICIENCY NOTES & GLAZING CALCULATIONS FOR DETAILS.

WET AREAS PROTECTED WITH A WATERPROOFING SYSTEM IN ACCORDANCE WITH NCC 2022 PART H4D2 AND HOUSING PROVISIONS PART 10.2.

STEPS: TREAD- 240mm MIN, RISER- 190mm MAX

- AT STEPS- 865mm (MIN) HIGH - AT LANDING- 1000mm (MIN) HIGH

WHERE REQUIRED, HORIZONTAL & VERT. GAPS IN BALUSTRADES MUST BE LESS THAN 125mm IN ACCORDANCE WITH HOUSING PROVISIONS PART 11.3.4

WRITTEN DIMENSIONS WILL TAKE PRECEDENCE OVER SCALE.

- UNLESS OTHERWISE INDICATED ALL WALL DIMENSIONS ARE:

- INTERNAL 90mm STUD

- WC / BATHROOM DOOR TO BE REMOVABLE WHERE REQUIRED AND FITTED WITH LIFT OFF HINGES IN ACCORDANCE WITH ABCB HOUSING PROVISIONS PART 10.4.2

ALL GLAZING TO COMPLY WITH NCC 2022 PART H1D8 & AS 1288

- MECHANICAL VENTILATION TO OUTSIDE AIR PROVIDED WHERE REQUIRED AND IN ACCORDANCE WITH NCC 2022 PART H4D7 $\,$

- ROOF TRUSSES (WHERE USED) TO HAVE A MAXIMUM SPACING OF 900mm WINDOW GLAZING CODES

- (OBS) OBSCURE GLASS - (TLS) TRANSLUCENT GLASS - (DG) DOUBLE GLAZED

RA: - ROOF ACCESS (WHERE APPLICABLE)

- SMOKE DETECTOR (DIRECT WIRED)

□ DP - DOWNPIPE (STORMWATER CONNECTED)

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Callen Bray

Building Design & Drafting Residential - Commercial - Industrial ABN: 38 040 205 161

Proposed SSD,

Bayswater, VIC 3153

At: Lot 23, No. 919 Mountain Hwy,

7.13m x 8.2m 2 Bedroom

Issue: 12/05/25 Rev: 01


Sheet No: 3


Building Fabric R-Values


Roof C	onstruction	
- Unventile - 0.90 Sol	Zone 6: Upward Heat Flow ated Roof Space ar Absorptance (Dark Grey) alue to be achieved R-5.1	
1.	Outdoor Air Film (7 m/s)	R- 0.04
2.	Metal Roof Cladding	R- 0.00
3.	Poly Backed Ref. Foil Ins. (Ref. side down)	R- 0.00
4.	Reflective Roof Airspace	R- 0.55
	(as per B.C.A 3.12.1.2)	
5.	Ceiling Insulation Batts (210mm)	R- 5.00
6.	Plasterboard Ceiling	R- 0.06
7.	Inside Air Film (Still Air)	R- 0.11
	<u>Total</u>	<u>R- 5.8</u>


Wall Co	<u>onstruction</u>		
- Climate - Min R-Vo	Zone 6 alue to be achieved R- 2.8		
1.	Outdoor Air Film (7 m/s)		R- 0.04
2.	F.C. Plank Cladding		R- 0.09
2. 3. 4.	Wall Insulation Batts (90mm)		R- 2.50
	Plasterboard (10mm)		R- 0.06
5.	Inside Air Film (Still Air)	R- 0.12	
	<u>Total</u>		R- 2.8

Floor Construction				
- Enclose	e Zone 6: Downward Heat Flow ed Sub-Floor Value to be achieved R- 2.25			
1.	"Sancell Breeze" Reflective Foil Insuation (4mm)	R- 0.10		
2.	Sealed Reflective Airspace (90mm) (As per Sancell Products Specs.)	R- 2.80		
	<u>Total</u>	<u>R- 2.9</u>		
	13130			

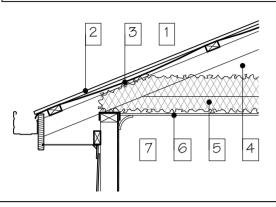


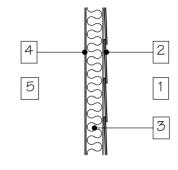

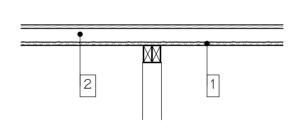


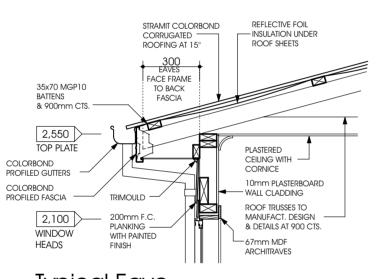



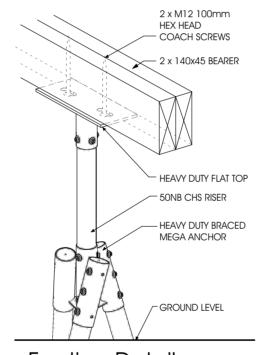

Footing Detail
Mega Anchor Bearer Connection
Scale 1:10

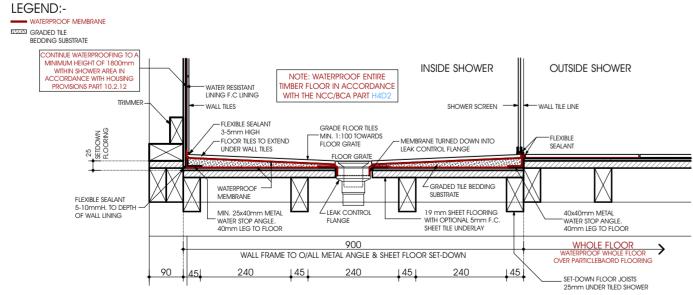

900mm Tiled Walk-In Shower

FULLY AWARE, IF ANY FURTHER CHANGES ARE TO BE MADE ON THESE
PLANS WILL INCUR A VARIATION FEE.

SIGNED:

DATE:

Proposed SSD,
At: Lot 23, No. 919 Mour Bayswater, VIC 3153

For: Betnale Pty. Ltd.

Bui Res

620 B/TOP

1,000

Callen Bray

Building Design & Drafting Residential - Commercial - Industrial ABN: 38 040 205 161 Phone: 0419 441 186 Email: Callen Bray@Hotmail.com Registered Building Practitioner: DP-AD 36967

Proposed SSD,
At: Lot 23, No. 919 Mountain Hwy,
7.13m x 8.2m
2 Bedroom

600 305 450 20 1,190 20 600 CARCASS DRAWERS B/TOP TO B/TOP CARCASS

| 250 | BULKHD | 310 375 16 600 16 585 585 16 | O/HEADS | R/HOOD |

SLIDEOUT

600 400 375 16 600 16 375 600 CARCASS OVEN CARCASS

1,960 B/TOP TO B/TOP

RANGEHOOD

250mm DEEP LAMINATE BULKHEAD OVER

(C)

DRYER SPACE

16 740 700 16 WM SPACE

STONE B/TOP

Laundry

UNDER SIN

DOUBLE T. RAIL

250 BULKHD

310 O/HEADS 1900x900 STEPLESS TILED SHOWER BASE

B

© 450 760 TOILET VANITY

Internal Elevations- Bathroom

1,000 900 SWR SCREEN

> TILED WINDOW REVEAL WITH — WATERPROOFING IN ACCORDANCE WITH AS 3740

2100H. x 900W. XED GLASS SCREEN

TILED SHOWER
RECESS:
350x900mm
9mm FLOORIN
BACKING)

950 SHOWER MIXER

Bathroom

A

Kitchen

Kitchen

I/WE.

550mm DEEP
LAMINATE——
BULKHEAD OVER

±250 BULKHD

310 O/HEADS

500 900 500 TILED RECESS

DW SPACE

> 1,780 B/TOP TO B/TOP

REF. POS

ACKNOWLEDGE THAT THESE PLANS ARE A TRUE AND ACCURATE

(TRADING AS SUPERIOR GRANNY FLATS) AND MYSELF/OURSELVES AND AUTHORISE THEIR USE FOR NEXT STAGE PURPOSES. I/WE AM/ARE

REFLECTION OF OUR REQUIREMENTS AND AGREE THAT THESE

PLANS ARE THE PLANS REFFERED TO IN THE MAJOR DOMESTIC

BUILDING CONTRACT BETWEEN "BETNALE PTY LTD"

250mm DEEP
LAMINATE
BULKHEAD OVER

220 600 16 800 170 585 145 SS DW SPACE CARCASS O/HANG

50 50 BULKHO SETBACK

16 950 16 600 400 600 REF. SPACE CARCASS

250_ BULKHD

600 310 O/HEADS

Scale 1:50 @ A2 1900x900 STEPLESS TILED SHOWER BASE

| 360 | C | T.P.H | 460 | | VANITY |

7.13m x 8.2m Sheet No: 4
2 Bedroom Issue: 12/05/25
Rev: 01