

- Stormwater: 90mm PVC underslung beneath unit then underground to connect to existing as required by relevant authority.



OVERALL SITE AREA: 604 m²

EXISTING DWELLING: 92 m²
EXISTING CLASS 10: 7 m²

PROPOSED SSD: $59 \text{ m}^2 (+64\%)$

PROPOSED SSD DECK: 10 m²
PROPOSED SSD CARPORT: 19 m²

OVERALL SITE COVERAGE: 187 m² (31%)

TOTAL PERMEABLE AREA: 286 m² (47%)



Callen Bray

Building Design & Drafting Residential - Commercial - Industrial ABN: 38 040 205 161 Phone: 0419 441 186 Email: Callen_Bray@Hotmail.com Registered Building Practitioner: DP-AD 36967

Proposed SSD,

At: Lot 178, No. 75 Lewis St, Springvale, VIC, 3171 For: Betnale Pty. Ltd. 9.41m x 6.21m 2 Bedroom Sheet No: 1 Issue: 03.07.24 Rev: 05

SPECIFICATION

FOOTINGS

"TYPE 1" FOOTINGS TO AS 1684.2 CONCRETE BACKFILL TO ENGINEER'S SPECIFICATIONS

SITE CLASSIFICATION

MIN. DEPTH

AS PER SOIL REPORT FROM: 'SOIL TEST MELBOURNE'' 02/04/24 NOTE: FOOTINGS MUST ALSO BE FOUNDED A MIN. OF 100mm INTO NATURAL SOIL WITH A MIN. BEARING CAPACITY OF 100 KPa. A DEEPER FOUNDING DEPTH MAY BE REQUIRED TO ACHIEVE THIS

STUMPS

S1: 100x100 PRECAST CONCRETE STUMPS WITH ONE 5mm HARD DRAWN WIRE.

P1: 100x100 CYPRESS TIMBER POSTS/NEWEL POSTS WITH A MIN. STRESS GRADE OF F4 ON POST ANCHORS.

BEARERS

2/140x45 LVL 15 (F17) BEARERS WITH A MAX. CONTINUOUS SPAN OF 2400mm.

MINIMUM BEARER CLEARANCE

TO GROUND LEVEL: TERMITE INSPECTION REQUIRED:

NOT REQUIRED:

NOTE: ON SLOPING SITES, 400mm WHEN REQUIRED MAY BE REDUCED TO 150mm WITHIN 2m OF EXTERNAL WALLS

FLOOR JOISTS

- 90x45 MGP10 FLOOR JOISTS AT MAX. 450 CENTRES WITH A: MAX. CONTINUOUS OF 1800mm MAX. SINGLE SPAN OF 1300mm

FLOORING

19mm THICK "YELLOW TONGUE" PARTICLEBOARD FLOORING.

TIMBER DURABILITY

CLASS 1 OR 2 TIMBERS ARE SUITABLE FOR IN GROUND USE. ALTERNATIVELY, H5 TREATED TIMBER CAN BE USEI CLASS 1 CLASS 2

BELIAN CYPRESS (WHITE) IRONBARK KWILA (MERBAU) SPOTTED GUM WESTERN RED CEDA TALLOWWOOD TURPENTINE YELLOW CEDAR NORTHERN BOX RIVER RED GUM

WALL FRAMES

COMMON STUDS: TOP/BOTTOM PLATES: NOGGINGS:
JAMB STUDS:
OPENING 0 - 900:
OPENING 900 - 2600:
OPENING 2600 - 4300: 90x35 AT 1275 CTS.

LINTELS

OPENINGS UP TO 1100: 90 x 45 F5 OPENINGS UP TO 1500: 90 x 45 LVL 15 OPENINGS UP TO 1800: 140 x 45 F7 OPENINGS UP TO 2200: 140 x 45 LVL 15 OPENINGS UP TO 2400: 190 x 45 F7

OPENINGS UP TO 2400: 130 x 43 F7 OPENINGS UP TO 2600: 190 x 45 MGP10 OPENINGS UP TO 3000: 240 x 45 F7 ALL STRUCTURAL TIMBER SIZES, FIXINGS & TIE-DOWNS ARE TO BE IN ACCORDANCE WITH AS 1684.2 2010

MIN. FOOTING FOUNDING DEPTHS: IN ACCORDANCE WITH AS 2870

ENSURE VINYL FLOORING IS DEEMED TO BE WATERPROOF & THAT ALL JOINS ARE SEALED UPTURN VINYL MIN, 25mm AT WALL/FLOOR JUNCTIONS O CREATE WATERPROOF WATER STOP. SKIRTING 30ARDS & ARCHITRAVES PLACED OVER UPTURN & SEALED TO VINYL WITH WATERPROOF ACRYLIC OR SILICONE SEALANT (REFER TO DETAIL)
SKIRTING BOARDS & ARCHITRAVES TO WET AREAS TO
BE SOLID TIMBER (IE. PINE OR HARDWOOD, <u>NOT MDF</u>)

WATERPROOFING & WATER RESISTANCE

ALL WET AREA FLOORS:

42x42x3mm ALUMIN, WATERSTOP ANGLE OR VINYL THERMOSET LAMINATE WALL PANELS MIN. OF 1800mm

HIGH FROM SHOWER BASE ABOVE BASINS, TROUGHS & SINKS (KITCHEN BENCH 50mm HIGH WALL TILES MIN. ABOVE VESSELS WITH

WATERPROOF ACRYLIC OR SILICONE SEALANT TO

ELECTRICAL NOTES

LIGHT SWITCHES TO BE AT 1000mm ABOVE FLOOR LEVEL.
HEIGHTG OF POWER POINTS MEASURED FROM
FLOOR LEVEL UNLESS OTHERWISE NOTED.
UNLESS DIMENSIONED POWER POINTS TO BE LOCATED TO THE NEAREST STUD. POWER POINTS FOR APPLIANCES & SPLIT SYSTEM AIR-CONDITIONING TO SUIT MANUFACTURERS REQ. PROVIDE PHONE CABLING WITH CONDUIT & DRAW STRING PLUS T.V. ANTENNA CABLING THROUGH BARGE END.

ENERGY EFFICIENCY- LIGHTING

ARTIFICIAL LIGHTING MUST NOT EXCEED: VERANDAH/PORCH- 4W/m² PERIMETER LIGHTING- MIN. 40 LUMENS/W IN ACCORDANCE WITH THE B.C.A PART 3.12

INTERNAL LIGHTING MUST NOT EXCEED: 300 WATTS TOTAL

PERIMETER LIGHTING COMPLIANT WITH: 8 WATT CFL GLOBE= 50 LUMENS/W 11 WATT CFL GLOBE= 73 LUMENS/W

ELECTRICAL LEGEND

GELF SEALING)

- SMOKE DETECTOR
(DIRECT WIRED)

- LED DOWNLIGHT S/B - INTERNAL - T.V. POINT AT 200

SPP	DPP	HEIGHT	SPP	DPP	HEIGHT
		200 F.F.L	\otimes	<u> </u>	1200 F.F.L
		350 F.F.L	1	Δ	1275 F.F.L
\triangle	•	750 F.F.L	Ø		1350 F.F.L
		970 F.F.L	0		1400 F.F.L
<u>a</u>	<u> </u>	1000 F.G.L	0		2000 F.F.L

△ 1000F.F.L TERMITE AREAS

HE PLACEMENT OF A CHEMICAL BARRIER OR SHEET METAL "ANT CAPS" TO THE TOPS OF TIMBER STUMPS I ACCORDANCE WITH PART 3.1.3 OF THE BCA & AS 3660

IOTE: A MIN. OF 400mm CLEARANCE IS REQUIRED TO THE UNDERSIDE OF BEARERS ON SITES REQUIRING TERMITE INSPECTION. THIS CAN BE REDUCED TO 150mm ON SLOPING SITES WITHIN


BUSHFIRE AREAS

DESIGN & SPECIFICATION DOES NOT CONSIDER SITES SUBJECT TO BUSHFIRE ATTACK. SITES DEEMED TO HAVE A BAL OF 12.5 OR MORE HAVE ADDITIONAL CONSTRUCTION REQUIREMENTS IN ACCORDANCE WITH PART 3.7.4 OF THE BCA & AS 3959

INTERNAL ELEVATIONS SPECIFICATION


		WATER PIP	E LO	CATIONS		FITTING LOC	CATIONS
No.	ITEM	ABOVE FFL	No.	ITEM	ABOVE FFL	ITEM	HEIGHT ABOVE FFL
1	TOILET	250	6	SINK	650	PAPER HOLDER	820
2	BIDET	250	7	DW	500	TOWEL RAIL	1000/1600
3	BATH	600	8	TROUGH	1085	TOWEL RING	820
4	SHOWER	1000/1800	9	WM	600/1275	SHOWER SOAP HOLDER	1000 NOMINAL
5	BASIN	600	10	FR WASTE	-		

FRAME OFFSETS: SHOWER ROSE= 430 CL. SHOWER TAPS= 250 CL. SOAP HOLDER= 550 CL NOTES: - DIMENSIONS TAKEN FROM FRAME - SPLASHBACK TILES: 200x200 - WET AREA SKIRTING BOARDS: - POWERPOINT LOCATION

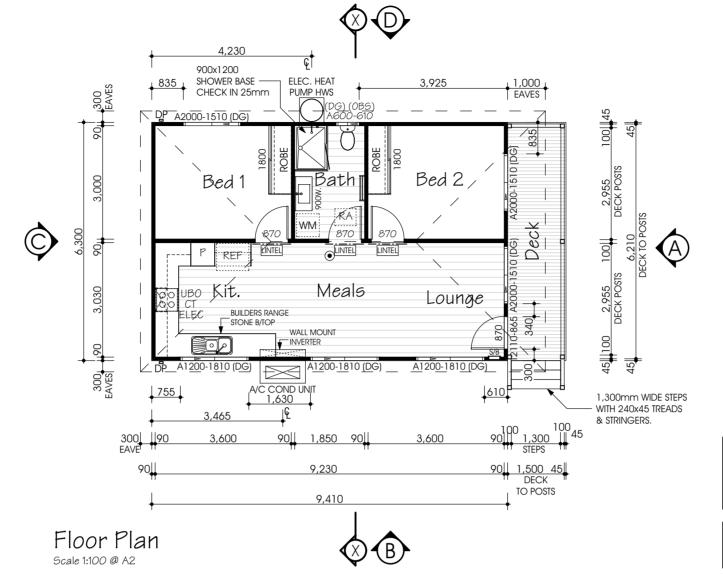

FLOOR A	AREAS
GRD. FL.	60.0m ²
SUB TOTAL	60.0m ²
DECK	9.3m ²
TOTAL	69.3m ²

FLOOR COV	ERING AREA
HYBRID	28.6 m ²
CARPET	21.8 m ²

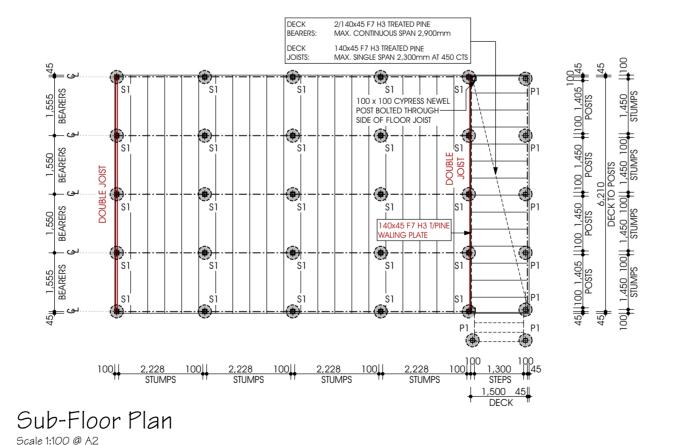

ELEC. HEAT PLIMP HWS BATHROOM EXT. FAN DUCTED THROUGH EAVE 20W RANGEHOOD EXT. FAN RANGEHOOD-OVER COOKTOP - WISWITCH A/C COND UNIT

Electrical Plan Scale 1:100 @ A2

I/WE

ACKNOWLEDGE THAT THESE PLANS ARE A TRUE AND ACCURATE REFLECTION OF OUR REQUIREMENTS AND AGREE THAT THESE PLANS ARE THE PLANS REFFERED TO IN THE MAJOR DOMESTIC BUILDING CONTRACT BETWEEN "BETNALE PTY LTD" (TRADING AS SUPERIOR GRANNY FLATS) AND MYSELF/OURSELVES ÀND AUTHORISE THEIR USE FOR NEXT STAGE PURPOSES. I/WE AM/ARE FULLY AWARE, IF ANY FURTHER CHANGES ARE TO BE MADE ON THESE PLANS WILL INCUR A VARIATION FEE.

SIGNED: DATE: DATE: .. SIGNED:



Callen Bray

Building Design & Drafting Residential - Commercial - Industrial ABN: 38 040 205 161 Phone: 0419 441 186
Email: Callen_Bray@Hotmail.com
stered Building Practitioner: DP-AD 36967

Proposed SSD,

At: Lot 178, No. 75 Lewis St, Springvale, VIC, 3171 For: Betnale Pty. Ltd.

9.41m x 6.21m 2 Bedroom

ENERGY EFFICIENCY

INSULATION VALUES

EXTERNAL GLAZING

GENERAL NOTES

CALCULATIONS FOR DETAILS.

WINDOW GLAZING CODES:

- BALUSTRADE :

STEPS: TREAD- 240mm MIN. RISER- 190mm MAX.

WRITTEN DIMENSIONS WILL TAKE PRECEDENCE OVER SCALE.

UNLESS OTHERWISE INDICATED ALL WALL DIMENSIONS ARE:
- EXTERNAL 90mm STUD
- INTERNAL 90mm STUD

ALL GLAZING TO COMPLY WITH PART 3.6 OF THE BCA & AS 1288

WALLS: R- 2.5 WALL BATTS (90mm)

FLOOR: R- 2.1 UNDERFLOOR BATTS (75mm)

CLASS 1 BUILDINGS IN CLIMATE ZONE 6 ARE REQUIRED TO ACHIEVE A MIN. 6 STAR.

ROOF: R- 5.0 BATTS (210mm) + REFLECTIVE FOIL INSULATION*

* NOTE: REFLECTIVE FOIL INSULATION ASSUMES A SINGLE FOIL SIDED TYPE & POLY WEAVE BACKED WITH AN AVERAGE EMITTANCE VALUE OF 0.9 OUTER & 0.05 INNER. THE REFLECTIVE SIDE MUST FACE DOWNWARD (ROOP) OR INWARD (WALLS) AND BE PLACED DIRECTLY UNDER THE ROOF & WALL CLADDING TO BE EFFECTIVE.

- EXTERNAL GLAZING IS SUBJECT TO BUILDING ORIENTATION; REFER TO ATTACHED GLAZING CALCULATION FOR SPECIFIC BUILDING ORIENTATION

- A SEAL TO RESTRICT AIR INFILTRATION MUST BE FITTED TO EACH EDGE OF AN EXTERNAL SLIDING DOOR, WINDOWS AND OPENINGS.

- DRAFT PROTECTORS ARE REQUIRED TO BE FITTED TO THE BOTTOM EDGE OF EXTERNAL SWING DOORS AND SEALS TO THE HEAD AND SIDES.

- SEALS MAY BE FOAM, RUBBER, FIBROUS OR THE LIKE.

- EXHAUST FANS MUST BE FITTED WITH A SELF SEALING DEVICE SUCH AS A SELF-CLOSING DAMPER OR FILTER (RANGEHOOD).

- GAPS AND CRACKS AROUND ROOFS, EXTERNAL FLOORS, WALL/FLOOR/ROOF JUNCTIONS AND ADD CRACKS OF THE PROPERTY OF

AND AROUND WINDOW AND DOOR FRAMES MUST BE MINIMISED THROUGH GOOD CONSTRUCTION PRACTICE. AND WITH THE PLACING OF CLOSE FITTING INTERNAL LINING AT JUNCTIONS, CAULKING, SKIRTING, ARCHITRAYES AND CORNICES.

- ENERGY EFFICIENCY (WALL, FLOOR, ROOF INSULATION & GLAZING) IN ACCORDANCE WITH PART 3.12 OF THE BCA: REFER TO ENERGY EFFICIENCY NOTES & GLAZING

WET AREAS IN ACCORDANCE WITH PART 3.8.1 OF THE BCA FOR WATERPROOFING &

- AT STEPS- 865mm (MIN) HIGH - AT LANDING- 1000mm (MIN) HIGH

- WHERE REQUIRED, HORIZONTAL & VERT. GAPS IN BALUSTRADES MUST BE LESS THAN 125mm IN ACCORDANCE WITH BCA PART 3.9.2

- WC / BATHROOM DOOR TO BE REMOVABLE WHERE REQUIRED AND FITTED WITH LIFT OFF HINGES IN ACCORDANCE WITH BCA PART 3.8.3.3

- MECHANICAL VENTILATION TO OUTSIDE AIR PROVIDED WHERE REQUIRED AND IN ACCORDANCE WITH B.C.A. P.2.4.5 / 3.8.5

- (OBS) OBSCURE GLASS - (TLS) TRANSLUCENT GLASS - (DG) DOUBLE GLAZED

- ROOF ACCESS (WHERE APPLICABLE)

□ DP - DOWNPIPE (STORMWATER CONNECTED)

■ DP - DOWNPIPE (WATER TANK CONNECTED)

- SMOKE DETECTOR (DIRECT WIRED)

- ROOF TRUSSES (WHERE USED) TO HAVE A MAXIMUM SPACING OF $900\mathrm{mm}$

- SERVICES PIPING AND DUCTWORK MUST COMPLY WITH THE MIN. INSULATION REQUIREMENTS OF PART 3.12.5 OF THE BCA.

Sheet No: 2 Issue: 03.07.24 Rev: 05

SPECIFICATION

FOOTINGS

"TYPE 1" FOOTINGS TO AS 1684.2 CONCRETE BACKFILL TO ENGINEER'S SPECIFICATIONS

MIN. FOOTING FOUNDING DEPTHS:

IN ACCORDANCE WITH AS 2870 SITE CLASSIFICATION

MIN. DEPTH

NOTE: FOOTINGS MUST ALSO BE FOUNDED A MIN. OF 100mm INTO NATURAL SOIL WITH A MIN. BEARING CAPACITY OF 100 kPa. A DEEPER FOUNDING DEPTH MAY BE REQUIRED TO ACHIEVE THIS

STUMPS

61: 100x100 PRECAST CONCRETE STUMPS WITH ONE 5mm HARD DRAWN WIRE.

P1: 100x100 CYPRESS TIMBER POSTS/NEWEL POSTS WITH A MIN. STRESS GRADE OF F4 ON POST ANCHORS.

BEARERS

2/140x45 LVL 15 (F17) BEARERS WITH A MAX. CONTINUOUS SPAN OF 2400mm.

MINIMUM BEARER CLEARANCE

TO GROUND LEVEL: TERMITE INSPECTION REQUIRED:

NOT REQUIRED:

NOTE: ON SLOPING SITES, 400mm WHEN REQUIRED MAY BE REDUCED TO 150mm WITHIN 2m OF EXTERNAL WALLS

FLOOR JOISTS

90x45 MGP10 FLOOR JOISTS AT MAX. 450 CENTRES WITH A: MAX. CONTINUOUS OF 1800mm MAX. SINGLE SPAN OF 1300mm

FLOORING

19mm THICK "YELLOW TONGUE" PARTICLEBOARD FLOORING.

TIMBER DURABILITY

CLASS 1 OR 2 TIMBERS ARE SUITABLE FOR IN GROUND USE. ALTERNATIVELY, H5 TREATED TIMBER CAN BE USED

CLASS 2

CLASS 1

BELIAN CYPRESS (WHITE) IRONBARK KWILA (MERBAU) SPOTTED GUM WESTERN RED CEDAR TALLOWWOOD TURPENTINE YELLOW CEDAR NORTHERN BOX RIVER RED GUM

WALL FRAMES

OMMON STUDS TOP/BOTTOM PLATES:

NOGGINGS: JAMB STUDS: OPENING 0 - 900: OPENING 900 - 2600: OPENING 2600 - 4300: 90x35 AT 1275 CTS 90x35 MGP10 2/90x35 MGP10 3/90x35 MGP10

LINTELS

OPENINGS UP TO 1100: 90 x 45 F5
OPENINGS UP TO 1500: 90 x 45 LYL 15
OPENINGS UP TO 1800: 140 x 45 F7
OPENINGS UP TO 2200: 140 x 45 LVL 15
OPENINGS UP TO 2200: 140 x 45 F7 OPENINGS UP TO 2400: 130 x 43 F7 OPENINGS UP TO 2600: 190 x 45 MGP10 OPENINGS UP TO 3000: 240 x 45 F7

ALL STRUCTURAL TIMBER SIZES, FIXINGS & TIE-DOWNS ARE TO BE IN ACCORDANCE WITH AS 1684.2 2010

WATERPROOFING & WATER RESISTANCE ALL WET AREA FLOORS:

ENSURE VINYL FLOORING IS DEEMED TO BE WATERPROOF & THAT ALL JOINS ARE SEALED UPTURN VINYL MIN. 25mm AT WALL/FLOOR JUNCTIONS TO ORD AT WATERPOOR WATER ATTOR CHARGE. O CREATE WATERPROOF WATER STOP, SKIRTING 30ARDS & ARCHITRAVES PLACED OVER UPTURN & SEALED TO VINYL WITH WATERPROOF ACRYLIC OR

SILICONE SEALANT (REFER TO DETAIL)
SKIRTING BOARDS & ARCHITRAVES TO WET AREAS TO
BE SOLID TIMBER (IE. PINE OR HARDWOOD, <u>NOT MDF</u>)

42x42x3mm ALUMIN. WATERSTOP ANGLE OR VINYL FLOORING STRIP WITH MIN. HORIZONTAL DIMENSION OF 40mm EITHER SIDE, SEALED TO WALL AT ALL WAL JUNCTIONS (CORNERS) EXTENDING A MIN. OF 1800 MI FROM SHOWER BASE HERMOSET LAMINATE WALL PANELS MIN. OF 1800m

ABOVE BASINS, TROUGHS & SINKS (KITCHEN BENCH

50mm HIGH WALL TILES MIN. ABOVE VESSELS WITH WATERPROOF ACRYLIC OR SILICONE SEALANT TO

ELECTRICAL NOTES

HIGH FROM SHOWER BASE

LIGHT SWITCHES TO BE AT 1000mm ABOVE FLOOR LEVEL.
HEIGHTS OF POWER POINTS MEASURED FROM FLOOR LEVEL UNLESS OTHERWISE NOTED. UNLESS DIMENSIONED POWER POINTS TO BE LOCATED TO THE NEAREST STUD. POWER POINTS FOR APPLIANCES & SPLIT SYSTEM AIR-CONDITIONING TO SUIT MANUFACTURERS REQ. PROVIDE PHONE CABLING WITH CONDUIT & DRAW STRING PLUS T.V. ANTENNA CABLING THROUGH BARGE END.

ENERGY EFFICIENCY-LIGHTING

ARTIFICIAL LIGHTING MUST NOT EXCEED: CLASS 1 BUILDINGS- 5 W/m² VERANDAH/PORCH- 4W/m² PERIMETER LIGHTING- MIN. 40 LUMENS/W IN ACCORDANCE WITH THE B.C.A PART 3.12

INTERNAL LIGHTING MUST NOT EXCEED: 300 WATTS TOTAL

PERIMETER LIGHTING COMPLIANT WITH: 8 WATT CFL GLOBE= 50 LUMENG/W 11 WATT CFL GLOBE= 73 LUMENG/W

ELECTRICAL LEGEND

GELF SEALING)

- SMOKE DETECTOR
(DIRECT WIRED) - LED DOWNLIGHT

S/B - INTERNAL - T.V. POINT

	SWI	TCH BOARD	٠ بر	AT 20	10
SPP	DPP	HEIGHT	SPP	DPP	HEIGHT
		200 F.F.L	<u>&</u>	<u> </u>	1200 F.F.L
		350 F.F.L	A	Δ	1275 F.F.L
\triangle	•	750 F.F.L	0	•	1350 F.F.L
		970 F.F.L	0		1400 F.F.L
0	<u> </u>	1000 F.G.L			2000 F.F.L
\triangle		1000F.F.L	an		IN ROOF

TERMITE AREAS

HE PLACEMENT OF A CHEMICAL BARRIER OR SHEET METAL "ANT CAPS" TO THE TOPS OF TIMBER STUMPS I ACCORDANCE WITH PART 3.1.3 OF THE BCA & AS 3660

IOTE: A MIN. OF 400mm CLEARANCE IS REQUIRED TO THE UNDERSIDE OF BEARERS ON SITES
REQUIRING TERMITE INSPECTION. THIS CAN BE
REDUCED TO 150mm ON SLOPING SITES WITHIN

BUSHFIRE AREAS


DESIGN & SPECIFICATION DOES NOT CONSIDER SITES SUBJECT TO BUSHFIRE ATTACK. SITES DEEMED TO HAVE A BAL OF 12.5 OR MORE HAVE ADDITIONAL CONSTRUCTION REQUIREMENTS IN ACCORDANCE WITH PART 3.7.4 OF THE BCA & AS 3959


INTERNAL ELEVATIONS SPECIFICATION


		WATER PIP	E LO	CATIONS		FITTING LOC	CATIONS
No.	ITEM	ABOVE FFL	No.	ITEM	ABOVE FFL	ITEM	HEIGHT ABOVE FFL
1	TOILET	250	6	SINK	650	PAPER HOLDER	820
2	BIDET	250	7	DW	500	TOWEL RAIL	1000/1600
3	BATH	600	8	TROUGH	1085	TOWEL RING	820
4	SHOWER	1000/1800	9	WM	600/1275	SHOWER SOAP HOLDER	1000 NOMINAL
5	BASIN	600	10	FR WASTE	-		


NOTES: - DIMENSIONS TAKEN FROM FRAME - SPLASHBACK TILES: 200x200 - WET AREA SKIRTING BOARDS - POWERPOINT LOCATION

FRAME OFFSETS: SHOWER ROSE= 430 CL. SHOWER TAPS= 250 CL. SOAP HOLDER= 550 CL

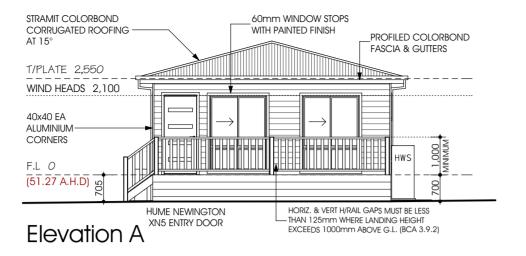

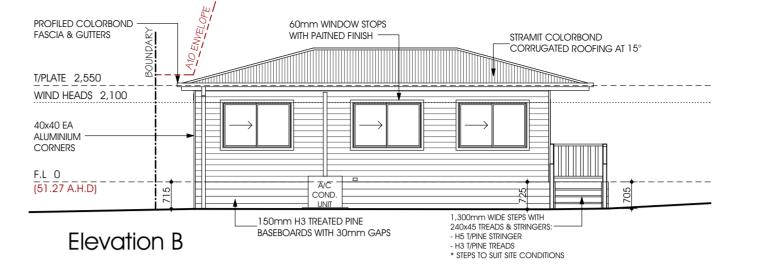


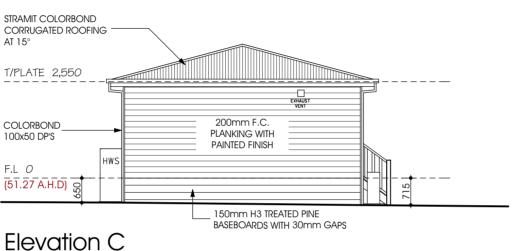


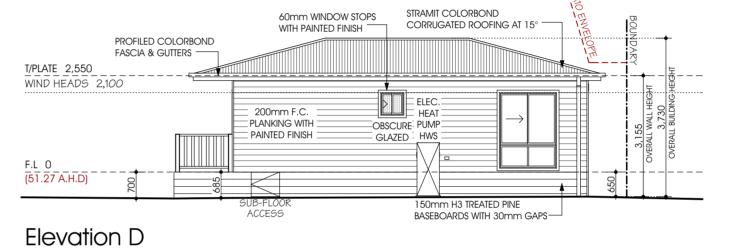

Elevations

Scale 1:100 @ A2

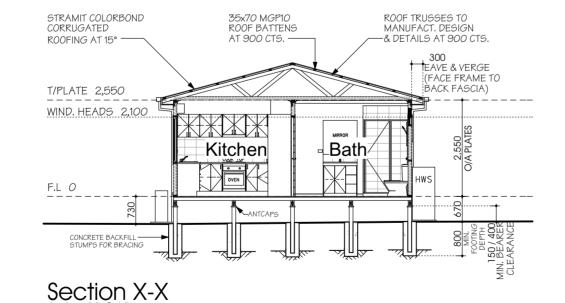

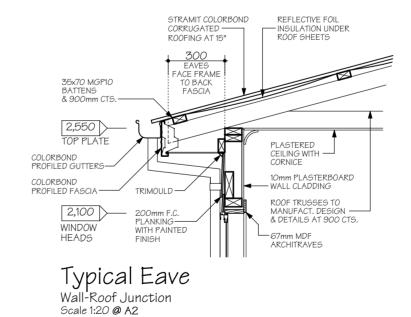

10mm WATER RESISTANT — P/BOARD SUBSTRATE THERMOSET - LAMINATE PANEL WATERPROOF i20 MIN. CHECK OUT Shower Detail Check into Wall Scale 1:5 @ A2

ENERGY EFFICIENCY

INSULATION VALUES

CLADDING TO BE EFFECTIVE

EXTERNAL GLAZING

GENERAL NOTES

BALUSTRADE:

WINDOW GLAZING CODES:

WALLS: R- 2.5 WALL BATTS (90mm)

FLOOR: R- 2.1 UNDERFLOOR BATTS (75mm)

CLASS 1 BUILDINGS IN CLIMATE ZONE 6 ARE REQUIRED TO ACHIEVE A MIN. 6 STAR

ROOF: R- 5.0 BATTS (210mm) + REFLECTIVE FOIL INSULATION*

NOTE: REFLECTIVE FOIL INSULATION ASSUMES A SINGLE FOIL SIDED TYPE & POLY WEAVE BACKED WIT AN AVERAGE EMITTANCE VALUE OF 0.9 OUTER & 0.05 INNER. THE REFLECTIVE SIDE MUST FACE DOWNWARD (ROOF) OR INWARD (WALLS) AND BE PLACED DIRECTLY UNDER THE ROOF & WALL

EXTERNAL GLAZING IS SUBJECT TO BUILDING ORIENTATION; REFER TO ATTACHED GLAZIN CALCULATION FOR SPECIFIC BUILDING ORIENTATION

A SEAL TO RESTRICT AIR INFILTRATION MUST BE FITTED TO EACH EDGE OF AN EXTERNAL SLIDING DOOR, WINDOWS AND OPENINGS.

DRAFT PROTECTORS ARE REQUIRED TO BE FITTED TO THE BOTTOM EDGE OF EXTERNAL SWING DOORS AND SEALS TO THE HEAD AND SIDES.

SEALS MAY BE FOAM, RUBBER, FIBROUS OR THE LIKE.

EXHAUST FANS MUST BE FITTED WITH A SELF SEALING DEVICE SUCH AS A SELF-CLOSI

PAPS AND CRACKS AROUND ROOFS, EXTERNAL FLOORS, WALL/FLOOR/ROOF JUNCTIONS

GAPS AND CRACKS AKOUND KOUPS, EATERNAL FLOURS, WALLT-LOURNOUT JUNG TOWN AND AROUND WINDOW AND DOOR FRAMES MUST BE MINIMISED THROUGH GOOD CONSTRUCTION PRACTICE. AND WITH THE PLACING OF CLOSE FITTING INTERNAL LINING AT

- ENERGY EFFICIENCY (WALL, FLOOR, ROOF INSULATION & GLAZING) IN ACCORDANCE WITH PART 3.12 OF THE BCA: REFER TO ENERGY EFFICIENCY NOTES & GLAZING CALCULATIONS FOR DETAILS.

WET AREAS IN ACCORDANCE WITH PART 3.8.1 OF THE BCA FOR WATERPROOFING & WATER RESISTANCE.

WHERE REQUIRED, HORIZONTAL & VERT. GAPS IN BALUSTRADES MUST BE LESS THAN 125mm IN ACCORDANCE WITH BCA PART 3.9.2

- WC / BATHROOM DOOR TO BE REMOVABLE WHERE REQUIRED AND FITTED WITH LIFT OFF HINGES IN ACCORDANCE WITH BCA PART 3.8.3.3

-MECHANICAL VENTILATION TO OUTSIDE AIR PROVIDED WHERE REQUIRED AND IN ACCORDANCE WITH B.C.A. P.2.4.5 / 3.8.5

:5: - (OBS) OBSCURE GLASS - (TLS) TRANSLUCENT GLASS - (DG) DOUBLE GLAZED

RA - ROOF ACCESS (WHERE APPLICABLE)

SMOKE DETECTOR (DIRECT WIRED)

□ DP - DOWNPIPE (STORMWATER CONNECTED)

■ DP - DOWNPIPE (WATER TANK CONNECTED)

- ROOF TRUSSES (WHERE USED) TO HAVE A MAXIMUM SPACING OF 900mm

JUNCTIONS, CAULKING, SKIRTING, ARCHITRAVES AND CORNICES.

STEPS: TREAD- 240mm MIN, RISER- 190mm MAX.

WRITTEN DIMENSIONS WILL TAKE PRECEDENCE OVER SCALE.

UNLEGG OTHERWIGE INDICATED ALL WALL DIMENGIONG ARE: - EXTERNAL 90mm GTUD - INTERNAL 90mm GTUD

SERVICES PIPING AND DUCTWORK MUST COMPLY WITH THE MIN. INSULATION REQUIREMENTS OF PART 3.12.5 OF THE BCA.

I/WE ACKNOWLEDGE THAT THESE PLANS ARE A TRUE AND ACCURATE REFLECTION OF OUR REQUIREMENTS AND AGREE THAT THESE PLANS ARE THE PLANS REFFERED TO IN THE MAJOR DOMESTIC BUILDING CONTRACT BETWEEN "BETNALE PTY LTD" (TRADING AS SUPERIOR GRANNY FLATS) AND MYSELF/OURSELVES ÀND AUTHORISE THEIR USE FOR NEXT STÁGE PURPOSES. I/WE AM/ARE FULLY AWARE, IF ANY FURTHER CHANGES ARE TO BE MADE ON THESE PLANS WILL INCUR A VARIATION FEE. SIGNED: DATE: DATE: .. SIGNED:



Callen Bray

Building Design & Drafting Residential - Commercial - Industrial ABN: 38 040 205 161 Phone: 0419 441 186 Email: Callen_Bray@Hotmail.com stered Building Practitioner: DP-AD 36967

Proposed SSD,

For: Betnale Pty. Ltd.

At: Lot 178, No. 75 Lewis St, Springvale, VIC, 3171

9.41m x 6.21m 2 Bedroom


Sheet No: 3 Issue: 03.07.24 Rev: 05


Building Fabric R-Values


Roof	Construction	
- Unven	te Zone 6: Upward Heat Flow tilated Roof Space Solar Absorptance (Dark Grey) -Value to be achieved R- 5.1	
1.	Outdoor Air Film (7 m/s)	R- 0.04
2.	Metal Roof Cladding	R-0.00
3.	Poly Backed Ref. Foil Ins. (Ref. side down)	R-0.00
4.	Reflective Roof Airspace (as per B.C.A 3.12.1.2)	R- 0.55
5.	Ceiling Insulation Batts (210mm)	R-5.00
6.	Plasterboard Ceiling	R-0.06
7.	Inside Air Film (Still Air)	R- 0.11
	Total	<u>R-5.8</u>


Wall Co	nstruction	
- Climate 2 - Min R-Va	Zone 6 Ilue to be achieved R- 2.8	
1.	Outdoor Air Film (7 m/s)	R- 0.04
2.	F.C. Plank Cladding	R- 0.09
3.	Wall Insulation Batts (90mm)	R- 2.50
4.	Plasterboard (10mm)	R- 0.06
5.	Inside Air Film (Still Air)	R- 0.12
	Total	P-28

Floor Construction				
- Enclo	ate Zone 6: Downward Heat Flow osed Sub-Floor R-Value to be achieved R- 2.25			
1.	"Sancell Breeze" Reflective Foil Insuation (4mm)	R- 0.10		
2.	Sealed Reflective Airspace (90mm) (As per Sancell Products Specs.)	R- 2.80		
	Iotal	R- 2.9		

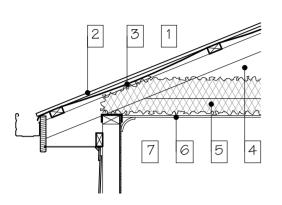

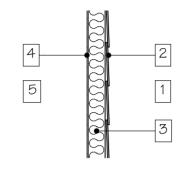

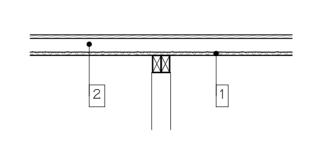

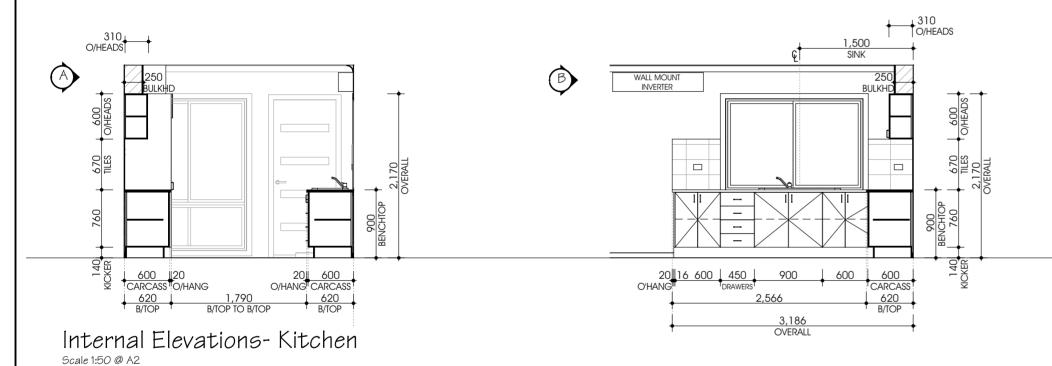

16, 590 590 16, 600 16, 590 430, 310
O/HEADS


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BULKHD


SINGEOUT RIPHOOD

SINGEOUT RIPHOOD


OON TOP


Kitchen

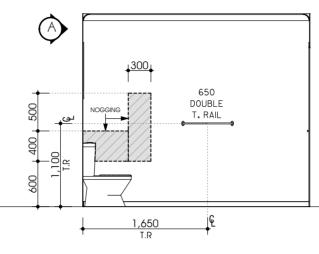

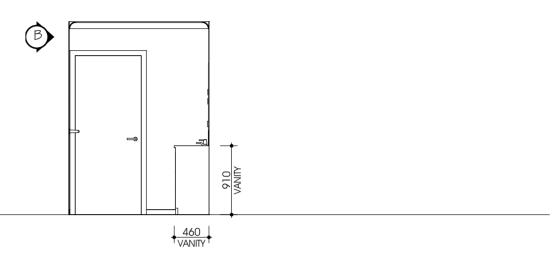

Internal Elevations- Bathroom

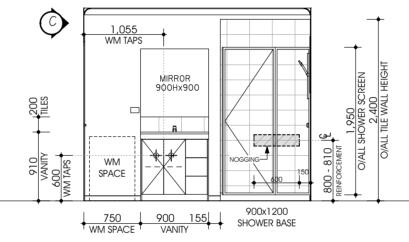

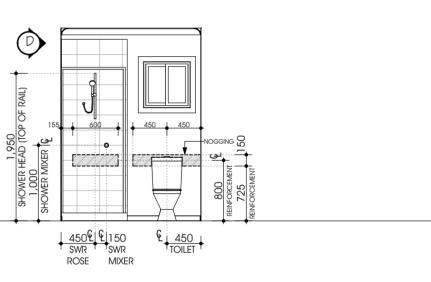

Bathroom

I/WE ..

ACKNOWLEDGE THAT THESE PLANS ARE A TRUE AND ACCURATE REFLECTION OF OUR REQUIREMENTS AND AGREE THAT THESE PLANS ARE THE PLANS REFFERED TO IN THE MAJOR DOMESTIC BUILDING CONTRACT BETWEEN "BETNALE PTY LTD" (TRADING AS SUPERIOR GRANNY FLATS) AND MYSELF/OURSELVES AND AUTHORISE THEIR USE FOR NEXT STAGE PURPOSES. I/WE AM/ARE FULLY AWARE, IF ANY FURTHER CHANGES ARE TO BE MADE ON THESE PLANS WILL INCUR A VARIATION FEE.




Callen Bray


Building Design & Drafting
Residential - Commercial - Industrial
ABN: 38 040 205 161
Phone: 0419 441 186
Email: Callen_Bray@Hotmail.com
Registered Building Practitioner: DP-AD 36967

Proposed SSD,
At: Lot 178, No. 75 Lewis St,
Springvale, VIC, 3171


2 Bedroo

9.41m x 6.21m 2 Bedroom Sheet No: 4 Issue: 03.07.24 Rev: 05

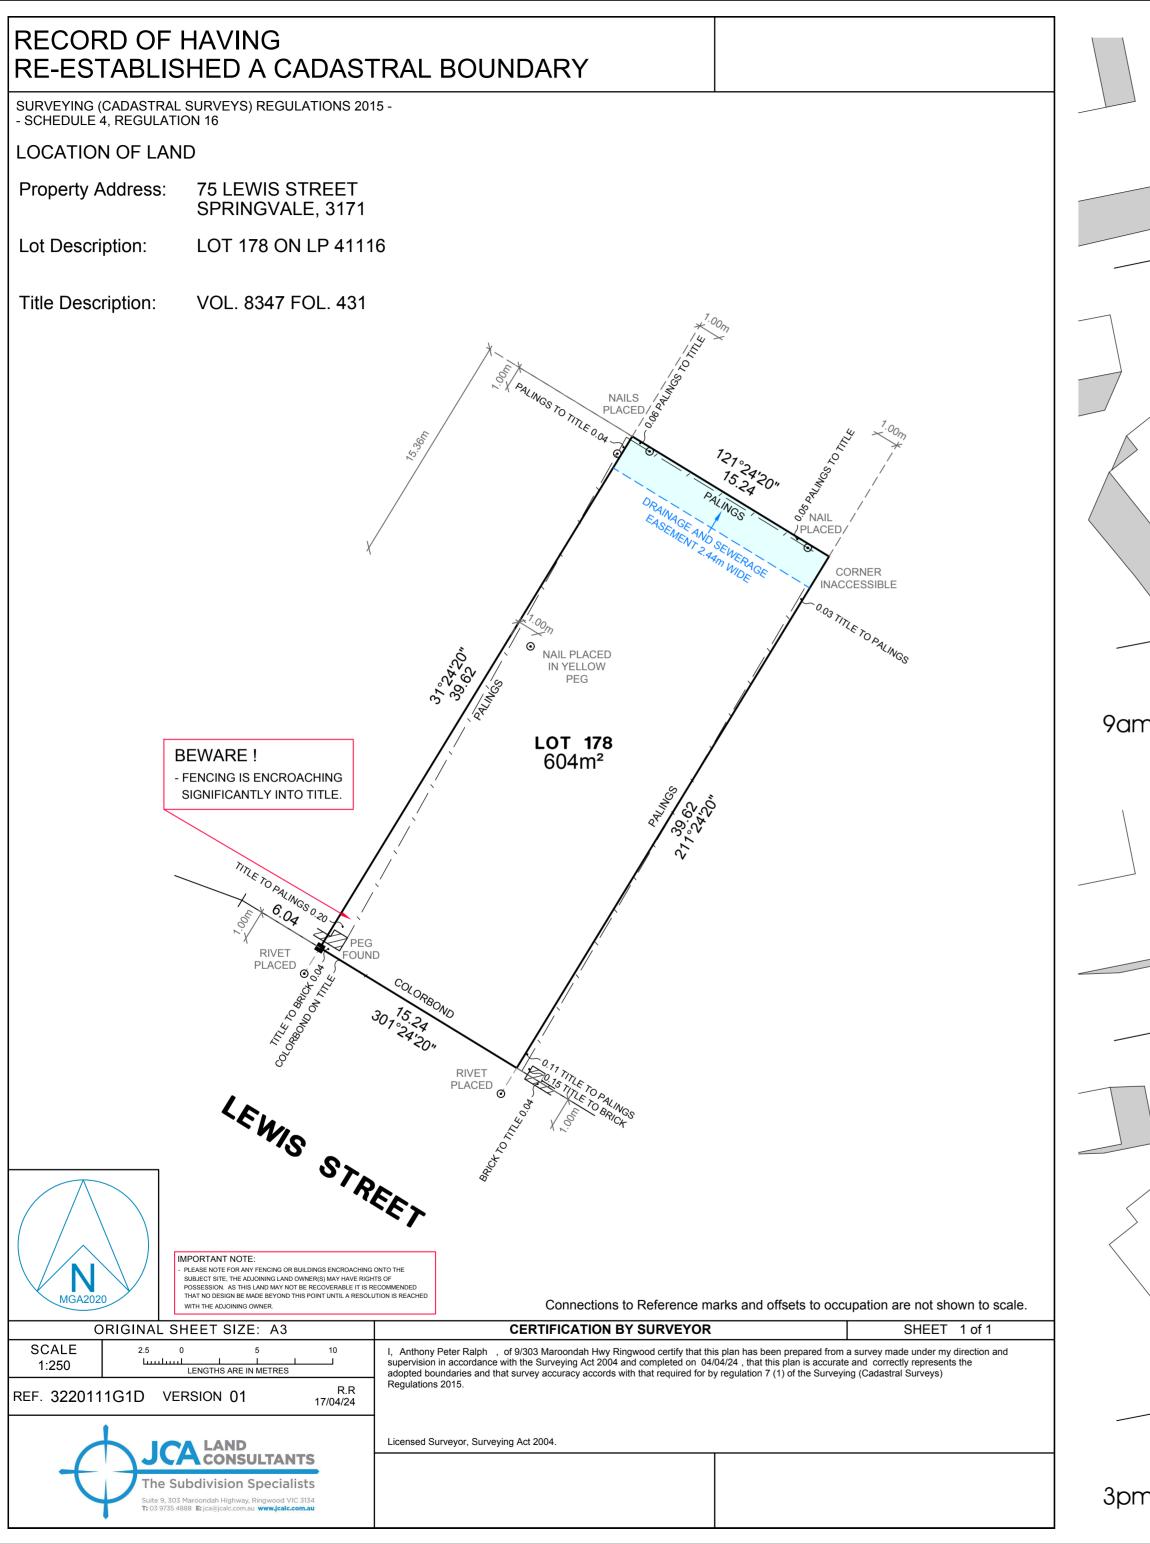


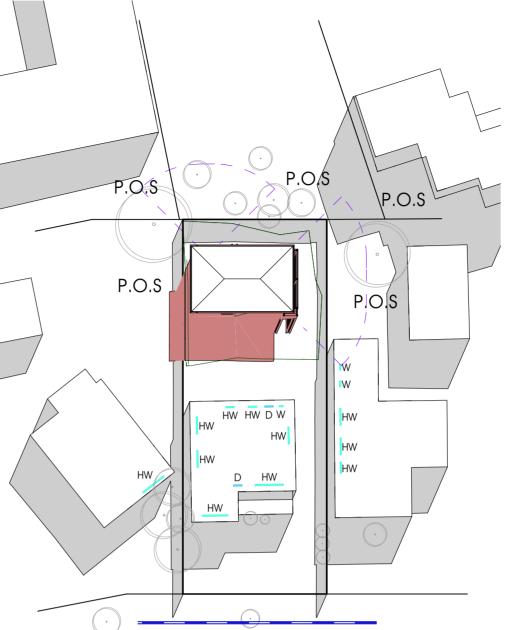


9am Shadow Diagram Scale 1:400 @ A2

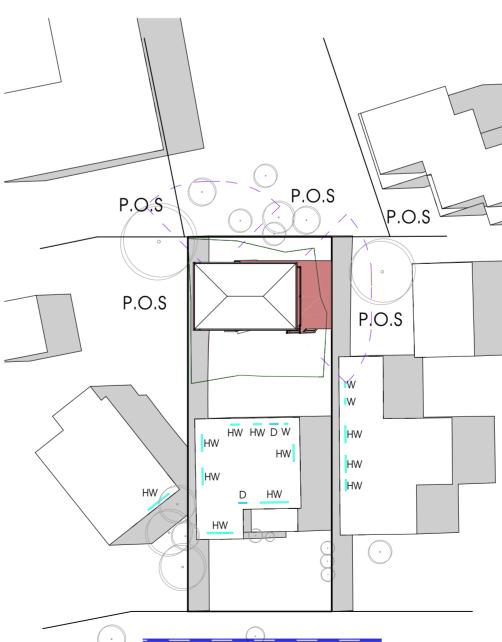

3pm Shadow Diagram Scale 1:400 @ A2

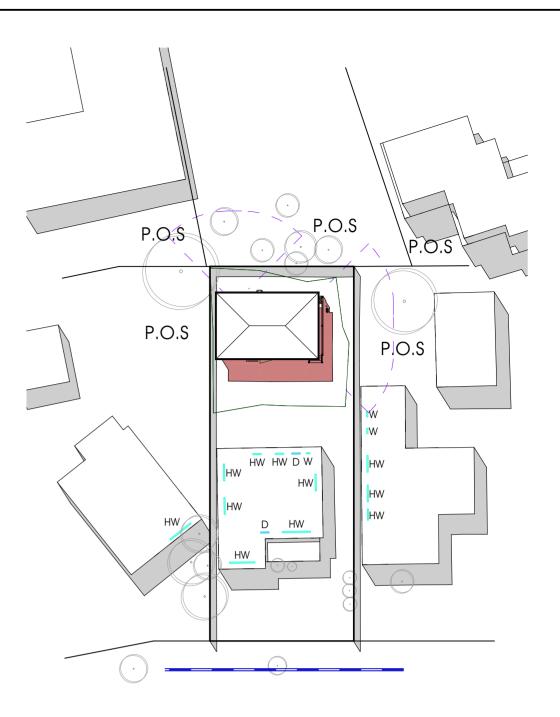

12pm Shadow Diagram Scale 1:400 @ A2

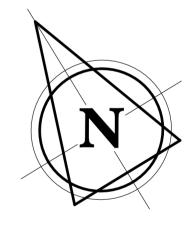

Shadow Diagrams Scale 1:400 @ A2



9m OVERLOOKING AREA



Existing Shadow Area



Proposed Shadow Area



Callen Bray

Building Design & Drafting
Residential - Commercial - Industrial
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Phone: 0419 441 186
Email: Callen Bray@Hotmail.com
Registered Building Practitioner: DP-AD 36967

Proposed SSD,

At: Lot 178, No. 75 Lewis St, Springvale, VIC, 3171

For: Betnale Pty. Ltd.

9.41m x 6.21m 2 Bedroom

Sheet No: 5 Issue: 03.07.24 Rev: 05